GENERAL NOTES:

1. ALL GRADING SHALL CONFORM TO THE RIVERSIDE MUNICIPAL CODE. TITLE 17 AND OF THE CURRENT CITY-ADOPTED EDITION OF THE CALIFORNIA BUILDING CODE.

2. ALL PROVISIONS OF THE PRELIMINARY SOILS REPORT PREPARED BY <u>SOILS EXPLORATION COMPANY INC.</u> ,DATED JANUARY 24, 2014 SHALL BE COMPLIED WITH DURING GRADING OPERATIONS. CITY BUSINESS TAX CERTIF. NO. 0123928, EXP. DATE <u>4-30-18</u>.

THIS PLAN IS FOR GRADING PURPOSES ONLY AND IS NOT TO BE USED FOR THE PURPOSE OF CONSTRUCTING ON-SITE OR OFF-SITE IMPROVEMENTS. ISSUANCE OF A PERMIT BASED ON THIS PLAN DOES NOT CONSTITUTE APPROVAL OF DRIVEWAY LOCATIONS STRUCTURAL SECTIONS OR LAYOUT, ADA-RELATED REQUIREMENTS, BUILDING LOCATIONS OR OR SIZES, PARKING LOT FOUNDATIONS, WALLS, CURBING, OFF-SITE DRAINAGE FACILITIES OR OTHER ITEMS NOT RELATED DIRÉCTLY TO THE BASIC GRADING OPERATION ON-SITE IMPROVEMENTS SHALL BE CONSTRUCTED FROM APPROVED BUILDING PERMIT PLANS. OFF-SITE IMPROVEMENTS SHALL BE CONSTRUCTED FROM PLANS APPROVED FOR THIS PURPOSE BY THE PUBLIC WORKS DEPARTMENT

CERTIFICATION FROM THE REGISTERED CIVIL ENGINEER STATING THAT THE GRADING HAS BEEN COMPLETED PER THE APPROVED PLAN, AND A COMPACTION REPORT FROM THE SOIL ENGINEER FOR FILL AREAS ARE REQUIRED PRIOR TO BUILDING PERMITS BEING ISSUED.

CONTRACTOR IS RESPONSIBLE FOR EROSION, DUST AND TEMPORARY DRAINAGE CONTROL DURING GRADING OPERATIONS.

A.)ALL MANUFACTURED SLOPES IN EXCESS OF 5 FEET IN VERTICAL HEIGHT ARE TO BE PROTECTED FROM EROSION DURING ROUGH GRADING OPERATIONS AND, THEREAFTER, UNTIL INSTALLATION OF FINAL GROUNDCOVER (SEE LANDSCAPE PLANS FOR FINAL GROUNDCOVER)

B.)ALL SLOPE PROTECTION SWALES TO BE CONSTRUCTED AT THE SAME TIME AS BANKS ARE GRADED.

C.)THE DEVELOPER AND HIS CONTRACTOR ARE RESPONSIBLE FOR IMPLEMENTATION AND MAINTENANCE OF THE EROSION CONTROL MEASURES SHOWN ON THIS PLAN AND SWPPP AND ALSO TO PROVIDE ANY ADDITIONAL EROSION CONTROL MEASURES (E.G., HYDROSEEDING, MULCHING OF STRAW, SAND BAGGING, DIVERSION DITCHES, RETENTION BASINS, ETC.) DICTATED BY FIELD CONDITIONS TO PREVENT EROSION AND OR THE INTRODUCTION OF DIRT. MUD OR DEBRIS INTO EXISTING PUBLIC STREETS AND/OR ONTO ADJACENT PROPERTIES DURING ANY PHASE OF CONSTRUCTION OPERATIONS. SPECIAL ATTENTION SHALL BE GIVEN TO ADDITIONAL EROSION CONTROL MEASURES NOTED ABOVE DURING DURING THE PERIOD OCTOBER 1 TO MAY 31.

D.)AFTER A RAINSTORM, ALL SILT AND DEBRIS SHALL BE REMOVED FROM CHECK BERMS AND CHECK DAMS. SILT AND DÉBRIS SHALL BE REMOVED FROM CITY OF RIVERSIDE STREETS THIS REQUIREMENT SHALL REMAIN IN EFFECT UNTIL CITY ACCEPTANCE OF THE SUBDIVISION THAT DRAINS ONTO CITY STREETS.

6. ANY ON—SITE RETAINING WALLS SHOWN ON THIS PLAN THAT ARE UNDER 3 FEET IN HEIGHT AND SUPPORT A SURCHARGE OR THAT ARE OVER 3 FEET IN HEIGHT REQUIRE SEPARATE REVIEW, APPROVAL AND A BUILDING PERMIT FROM THE BUILDING AND SAFETY DIVISION, COMMUNITY DEVELOPMENT DEPARTMENT. ANY NECESSARY RETAINING WALLS ON THE PERIMETER OF THIS SITE SHALL BE IN PLACE AND APPROVED BY THE BUILDING INSPECTOR PRIOR TO ISSUANCE OF THE GRADING PERMIT. APPROVED SEQUENCED GRADING WITH 11/2:1 MAXIMUM SLOPES TO WITHIN 2 FEET OF THE ADJACENT PROPERTY LINE MAY BE ACCEPTABLE TO ALLOW FOR ISSUANCE OF A GRADING PERMIT PRIOR TO COMPLETION OF ANY NECESSARY PERIMETER RETAINING WALLS. (IF NO RETAINING WALLS ARE SHOWN ON THE PLAN, DO NOT PUT THIS NOTE ON PLAN.

7. ANY IMPROVEMENTS CONSTRUCTED IN THE PUBLIC RIGHT-OF-WAY WILL REQUIRE A SEPARATE CONSTRUCTION PERMIT AND INSPECTION FROM THE PUBLIC WORKS DEPARTMENT.

8. ANY WALLS, FENCES, STRUCTURES AND/OR APPURTENANCES ADJACENT TO THIS PROJECT ARE TO BE PROTECTED IN PLACE. IF GRADING OPERATIONS DAMAGE OR ADVERSELY AFFECT SAID ITEMS IN ANY WAY, THE ONTRACTOR AND/OR DEVELOPER IS RESPONSIBLE FOR WORKING OUT AN ACCEPTABLE SOLUTION TO THE SATISFACTION OF THE AFFECTÉD PROPERTY OWNER(S).

9. THE CONTRACTOR/DEVELOPER IS RESPONSIBLE FOR ENSURING THAT RETAINING WALLS DO NOT INTERFERE WITH PROVISION OF UTILITIES.

10. IT IS THE GRADING CONTRACTOR'S RESPONSIBILITY TO ENSURE THAT ADEQUATE COMPACTION HAS BEEN ATTAINED ON THE ENTIRE GRADING SITE. INCLUDING FILL AREAS OUTSIDE THE BUILDING PAD AND ON ALL FILL SLOPES.

11. IT IS THE SOIL ENGINEER'S RESPONSIBILITY TO OBSERVE AND PERFORM COMPACTION TESTS DURING THE GRADING TO EVALUATE THE PREPARATION OF THE NATURAL GROUND SURFACE TO RECEIVE THE FILL AND THE COMPACTION ATTAINED IN THE FILL, INCLUDING FILL AREAS OUTSIDE THE BUILDING PADS AND TON ALL FILL SLOPES.

12. EARTHWORK QUANTITIES ARE SHOWN FOR GRADING PERMIT PURPOSES ONLY, AND THE CITY OF RIVERSIDE IS NOT RESPONSIBLE FOR THEIR ACCURACY.

13. FOR GRADING OF AREAS OF 1 ACRE OR MORE, A STORM WATER POLLUTION PREVENTION PLAN (SWPPP) SHALL BE KEPT ON-SITE AND MADE AVAILABLE UPON REQUEST OF A REPRESENTATIVE OF THE REGIONAL WATER QUALITY CONTROL BOARD (RWQCB) - SANTA ANA REGION AND/OR THE CITY OF RIVERSIDE.

14. GRADING OPERATIONS SHALL BE LIMITED TO BETWEEN THE HOURS OF 7 A.M. AND 7 P.M. ON WEEKDAYS AND BETWEEN 8 A.M. AND 5 P.M. ON SATURDAYS. NO GRADING WILL BE PERMITTED ON SUNDAY OR FEDERAL HOLIDAYS. (RIVERSIDE MUNICIPAL CODE, 7.35.010, ORDINANCE NO 6273)

ENGINEER'S NOTICE TO CONTRACTORS

1. THE EXISTENCE AND LOCATION OF ANY UNDERGROUND UTILITY PIPES OR STRUCTURES SHOWN ON THESE PLANS WERE OBTAINED BY A SEARCH OF AVAILABLE RECORDS. THESE LOCATIONS ARE APPROXIMATE AND SHALL BE CONFIRMED IN THE FIELD BY THE CONTRACTOR, SO THAT ANY NECESSARY ADJUSTMENT CAN BE MADE IN ALIGNMENT AND/OR GRADE OF THE PROPOSED IMPROVEMENT. THE CONTRACTOR IS REQUIRED TO TAKE DUE PRECAUTIONARY MEASURES TO PROTECT ANY UTILITY LINES SHOWN AND ANY OTHER LINES NOT OF RECORD OR NOT SHOWN ON THESE PLANS.

2. CARE SHOULD BE TAKEN TO PREVENT GRADED DITCHES AND SWALES FROM UNDERMINING STREET IMPROVEMENTS. UPON INSPECTION OF THE SITES, THE CITY ENGINEER MAY REQUIRE TEMPORARY UNITE SWALES,

3. ALL AREAS SHALL SLOPE A MINIMUM OF 1.0% TO STREETS, DRIVE OR SWALES UNLESS OTHERWISE NOTED. 4. QUANTITIES SHOWN HERE ARE FOR PLAN CHECKING PURPOSES ONLY. CONTRACTOR IS RESPONSIBLE TO PERFORM HIS OWN QUANTITIES TAKEOFF.

5. CONTRACTOR AGREES THAT HE SHALL ASSUME SOLE AND COMPLETE RESPONSIBILITY FOR JOB SITE CONDITIONS; DURING THE COURSE OF CONSTRUCTION OF THIS PROJECT. INCLUDING SAFETY OF ALL PERSONS AND PROPERTY; THAT THE REQUIREMENTS SHALL APPLY CONTINUOUSLY AND NOT BE LIMITED TO NORMAL WORKING HOURS; AND THE CONTRACTOR SHALL DEFEND, INDEMNIFY AND HOLD THE CITY OF RIVERSIDE AND THE ENGINEER HARMLESS FROM ANY AND ALL LIABILITY, REAL OR ALLEGED, IN CONNECTION WITH THE PERFORMANCE OF WORK ON THIS PROJECT, EXCEPTING FOR LIABILITY ARISING FROM THE SOLE NEGLIGENCE OF THE CITY OF RIVERSIDE OR THE ENGINEER.

 ANY EARTHMOVING THAT EXCEEDS THE RELATIVE DEPTH OF FIVE FEET BELOW THE CURRENT SURFACE BE MONITORED FOR PALEONTOLOGICAL SPECIMENS. THE PALEONTOLOGICAL MONITORING PROGRAM SHOULD BE IN CONCURRENCE WITH COUNTY GUIDELINES AND THE WESTERN CENTER, HEMET. PRIOR TO ANY IMPLEMENTATION, A PRIMP (PALEONTOLOGICAL RESOURCE IMPACT MITIGATION PLAN) SHOULD BE PREPARED AND APPROVED.

LEGEND



48 HOURS BEFORE YOU DIG

---- W ---- Existing water line ---SS-- Existing sanitary sewer line EXISTING SLOPE **EXISTING CONTOUR** ———601—— PROPOSED CONTOUR PROPOSED BLOCK WALL

= GRADE BREAK = HIGH POINT = EDGE OF PAVEMENT = DAYLIGHT = GROUND SHOT = WATER VALVE WATER MAIN = WATER METER

= ASPHALT CONCRETE

W.V. = FLOW LINE = FINISHED GRADE = BENCH MARK = LANDSCAPING = TOP OF GRATE = INVERT ELEVATION

TRW = TOP OF WALL R = RADIUST = TOP OF FOOTING(600) = EXIST. ELEVATION600 = PROPOSED ELEVATION FAG = FINISHED GRADE FRS = FINISHED SURFACE CAJON = CONTROL JOINT TOE = TOE OF SLOPE

CITY OF RIVERSIDE BUSINESS TAX ACCOUNT #74172 EXP. 7/31/19 TOP = TOP OF SLOPE TOP/D.L. = TOP OF SLOPE/DAYLIGHTENGINEERING • SURVEYING • LAND DEVELOPMENT OTC = TOP OF CURBFF = FINISHED FLOOR(951) 279-4041

CITY OF RIVERSIDE

ROUGH GRADING PLANS

TRACT NO. 37764

VICTORIA AVE. N 55°35'00" E 614.68' LOT 1 02 60, LOT 11 LOT 8 0 SIE LOT 12 LOT 7 LOT 4 LOT 6 830 LOT 14 TR 9991 M.B. 103/89-91

SCALE: 1"=60'

400 S. RAMONA AVE., STE. 202

FAX: (951) 279–2830

CORONA, CALIFORNIA 92879

INDEX MAP

CITY OF RIVERSIDE, CALIFORNIA

PLANNING DIVÍSION

R.C.E. No.

DATE MARK

C053038

OWNER AND DEVELOPER:

LA SIERRA VICTORIA DEVELOPMENT LLC HITESH PATEL 19215 WILD MUSTANG CT. APPLE VALLEY, CA 92307 (760) 963-3475 PH.

ENGINEERS:

SAKE ENGINEERS, INC. 400 S. RAMONA AVE. STE 202 CORONA, CA 92879 (951) 279-4041 PH.

SOILS ENGINEERS:

SOIL EXPLORATION COMPANY INC 7535 JURUPA AVE. UNIT C RIVERSIDE, CA 92504 (951) 688-7200 PH. (951) 688-7100 FAX

ESTIMATED GRADING QUANTITIES:

CUT: 12,500 C.Y. FILL: 12,500 C.Y.

TOTAL AREA; 9.91 ACRES DISTRUBED AREA: 8.81 ACRES

NOTE:

EARTH QUANTITIES SHOWN HERE ARE FOR RAW ESTIMATING PLAN CHECK FEES ONLY. GRADING CONTRACTOR IS RESPONSIBLE TO PERFORM THEIR OWN CALCULATIONS FOR EARTH VOLUME WITH THE SOIL'S ENGINEER'S RECOMMENDATION.

NOTICE TO CONTRACTORS

CONTRACTOR SHALL POTHOLE AT THE TIE-IN STATIONS AND AT ANY OTHER POINTS OF POTENTIAL CONFLICTS WITH UNDERGROUND FACILITIES BEFORE STARTING CONSTRUCTION. EXISTING SUBSURFACE UTILITY DATA ON DRAWINGS WERE COMPILED FROM INFORMATION FURNISHED BY VARIOUS SOURCES. NEITHER THE ACCURACY NOR THE COMPLETENESS OF THE INFORMATION SHOWN IS GUARANTEED PRIOR TO CONSTRUCTION. THE CONTRACTOR SHALL VERIEY THE LOCATION AND ELEVATION OF EXISTING WATER MAINS. GAS MAINS, SANITARY SEWERS, STORM DRAINS, FLECTRIC CONDUITS. TELEPHONE LINES AND ANY OTHER UTILITIES. WHICH MAY CONFLICT WITH THE DESIGN AND CONSTRUCTION OF THE PROPOSED IMPROVEMENTS. RIM ELEVATIONS SHOWN ON THESE PLANS ARE APPROXIMATE ONLY. THE RING AND COVER SHALL BE ADJUSTED IN THE FIELD TO MATCH THE FINISHED SURFACE OF THE PAVEMENT TO FORM A SMOOTI DRIVING SURFACE. THE CONTRACTOR IS REQUIRED TO TAKE DUE PRECAUTIONARY MEASURES TO PROTECT ANY UTILITY LINES SHOWN AND ANY OTHER LINES NOT OF RECORD OR NOT SHOWN ON THESE PLANS. THE CONTRACTOR SHALL BE HELD RESPONSIBLE FOR ALL COSTS FOR THE REPAIR OF ANY AND ALL DAMAGE TO THE CONTRACT WORK OR TO ANY UTILITY (WHETHER PREVIOUSLY KNOWN OR DISCLOSED DURING THE WORK) AS MAY BE CAUSED BY HIS OPERATIONS. UTILITIES NOT SHOWN ON THE DRAWING TO BE RELOCATED OR ALTERED BY OTHERS SHALL BE MAINTAINED BY THE CONTRACTOR. AT THE COMPLETION OF THE CONTRACT WORK, THE CONTRACTOR SHALL LEAVE ALL UTILITIES AND APPURTENANCES IN A CONDITION SATISFACTORY TO THE OWNERS AND THE CITY.

ASSESSOR'S PARCEL NUMBER:

136-220-016

LEGAL DESCRIPTION:

OF LOT 1 IN BLOCK 12 OF THE RESUBDIVISION OF LANDSW OF J.F.MOULTON AND H.B. PRAED, AS SHOWN BY MAP ON FILE IN BOOK 1 PAGES 49 AND 50 OF MAPS, RECORDS OF RIVERSIDE COUNTY.

BASIS OF BEARINGS:

THE CENTERLINE OF VICTORIA AVENUE BEING NORTH 55°35'00" EAST AS SHOWN ON M.B. 153/15-17.

BASIS OF ELEVATION:

CITY OF RIVERSIDE BM# D3-A2; P.K. NAIL AND TAG AT NORTHERLY CORNER OF A CONCRETE SLAB AT THE SOUTHERLY CORNER OF LA SIERRA AVE. AND THE WESTERLY INTERSECTION OF DUFFERIN AVE. ELEVATION: 882.135 (1988 ELEVATION)

EMERGENCY PHONE NUMBERS

COUNTY OF RIVERSIDE		
FIRE DEPARTMENT	(951)	782–5321
COUNTY OF RIVERSIDE SHERIFF	(951)	787-7912
COUNTY OF RIVERSIDE TRAFFIC DIVISION	(951)	782–5366
COUNTY OF RIVERSIDE TRAFFIC SIGNALS	(951)	782-5376
STREET SUPERINTENDENT	(951)	782-6127
RIVERSIDE SCHOOLS	(951)	788-7132
GOOD AMBULANCE	(951)	684-5520
PACIFIC BELL TELEPHONE	(800)	303-3000
SOUTHERN CALIFORNIA EDISON COMPANY	(951)	351-2450
SOUTHERN CALIFORNIA GAS COMPANY	(800)	227-2600
UNDERGROUND SERVICE ALERT	(800)	422-4133

UTILITIES

ELECTRIC	SO. CAL. EDISON CO. SO. CAL. GAS CO.
WATER	CITY OF RIVERSIDE
TELEPHONE	0111 01 1111211012

REFERENCE DRAWINGS:

S - 1398 S - 2157 STREET DWG. R - 4421

INDEX

SHEET No. SHEET TITLE COVER SHEET

- TYPICAL SECTIONS AND DETAILS
- ROUGH GRADING PLAN
- EROSION CONTROL PLAN
- BEST MANAGEMENT PRACTICE

REVISIONS

WDID #8 33C379764 PW17-0496

VICINITY MAF THOMAS BROTHERS MAP PAGE/GRID: PAGE 744, GRID G-3, 2004 EDITION ROUGH GRADING PLAN

SCALE: 1"=60'

DATE: 7-9-2019

JOB NO.: JN 3053

APPROVED DATE CAME PG. XX-X M.P. X


TRACT 37764

DRAWN: RL CITY OF RIVERSIDE DEPARTMENT OF PUBLIC WORKS


DESIGNED: RL CHECKED: SA

520-769200-470701 SHEET 1 of 5

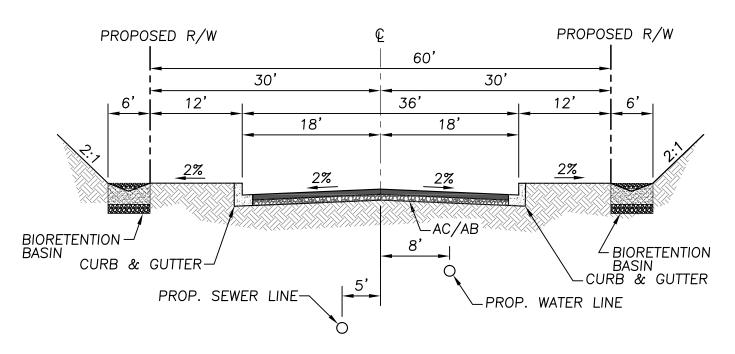
TYPICAL SECTION: LA SIERRA AVENUE



TYPICAL SECTION: GOLDTREE CT.

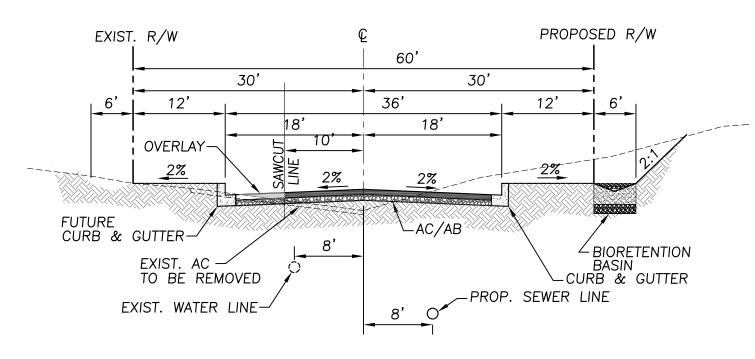


TYPICAL SECTION: MILLSWEET LANE

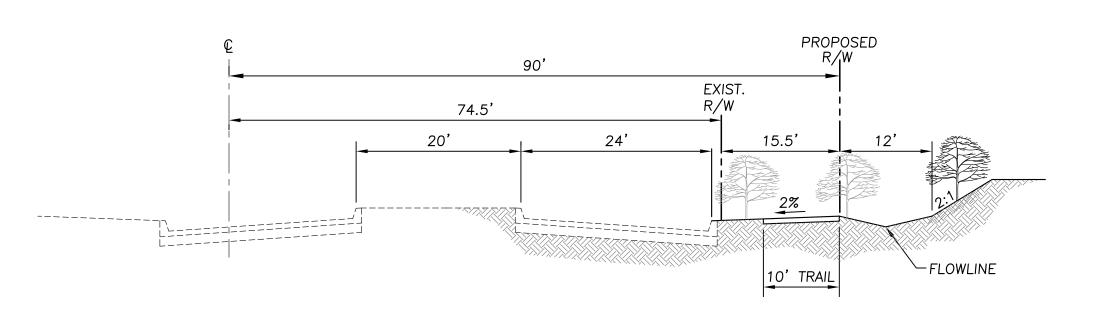

TYPICAL SECTION: VICTORIA AVENUE

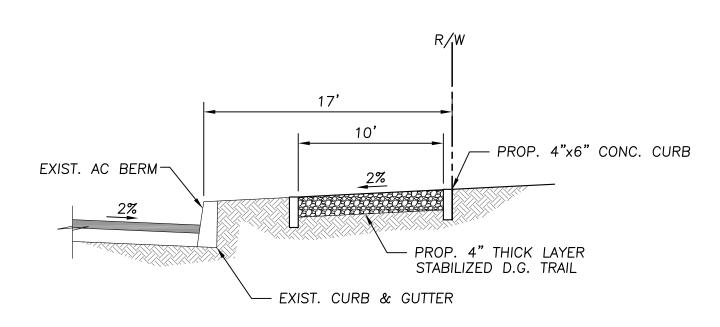NOTE
PROTECT IN PLACE TWO ROWS OF EXISTING MATURE
ORANGE TREES AND A THIRD ROW OF SHADE TREES TO
BE ADDED ACROSS THE FRONTAGE OF VICTORIA AVENUE
IN ACCORDANCE WITH THE VICTORIA AVENUE ADHOC
COMMITTEE DESIGN AND DEVELOPMENT STANDARDS AND
THE GENERAL PLAN 2025.




TYPICAL SECTION: MULTIPURPOSE TRAIL

CONSTRUCT TRAIL PER CITY STANDARD TRAIL N.T.
DETAILS AND TRAIL GRADING AND CONSTRUCTION
SPECIFICATIONS (SECTION 02211).
(SEE STREET IMPROVEMENT PLANS)

NOTE
PROTECT IN PLACE TWO ROWS OF EXISTING MATURE
ORANGE TREES AND A THIRD ROW OF SHADE TREES TO
BE ADDED ACROSS THE FRONTAGE OF VICTORIA AVENUE
IN ACCORDANCE WITH THE VICTORIA AVENUE ADHOC
COMMITTEE DESIGN AND DEVELOPMENT STANDARDS AND
THE GENERAL 2025 TRAILS MASTER PLAN.

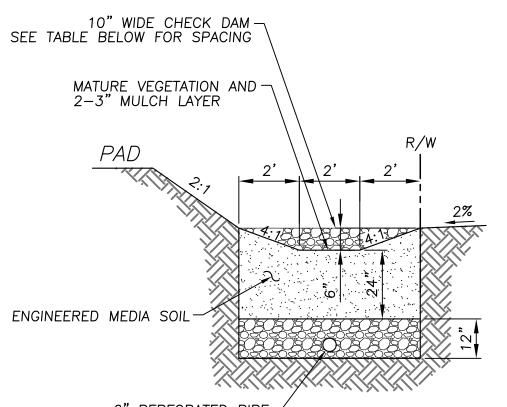COMPACTED STABILIZED DECOMPOSED GRANITE IS TO BE USED FOR THE TRAIL ACCORDING TO TRAIL GRADING AND CONSTRUCTION SPECIFICATIONS SECTION 02211 AND TRAIL DETAIL 1.



 SLOPE
 SPACING

 1%
 25 FEET

 2%
 15 FEET

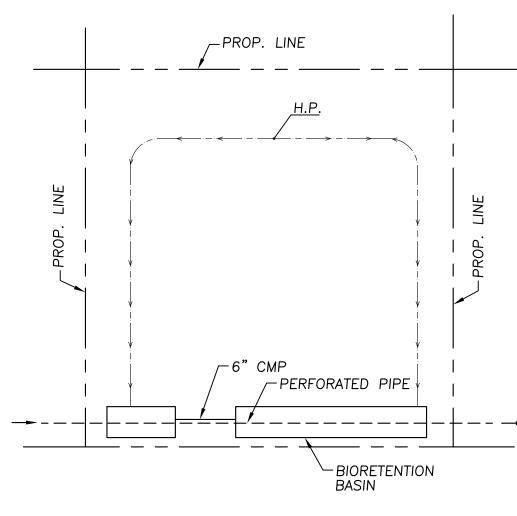
 3+%
 10 FEET

CHECK DAM SPACING


6" PERFORATED PIPE

LENGTH = PER PLAN


TYPICAL SECTION: BIORETENTION BASIN



TYPICAL PAD DETAIL

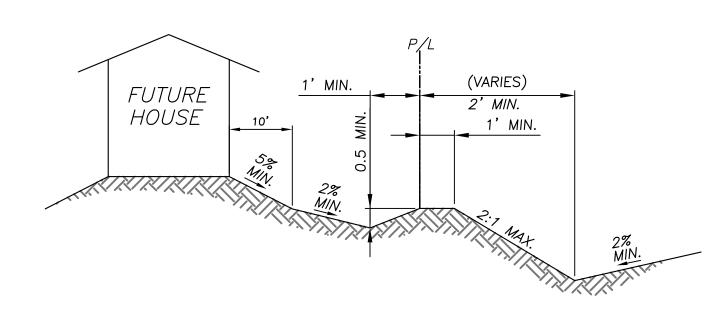


TYPICAL LOT DRAINAGE SECTION "A"

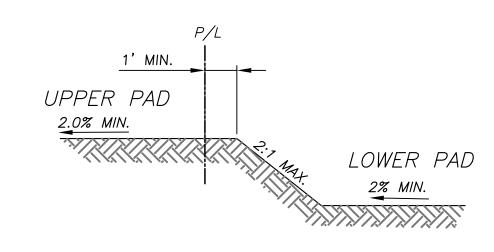

TYPICAL LOT DRAINAGE SECTION "B"

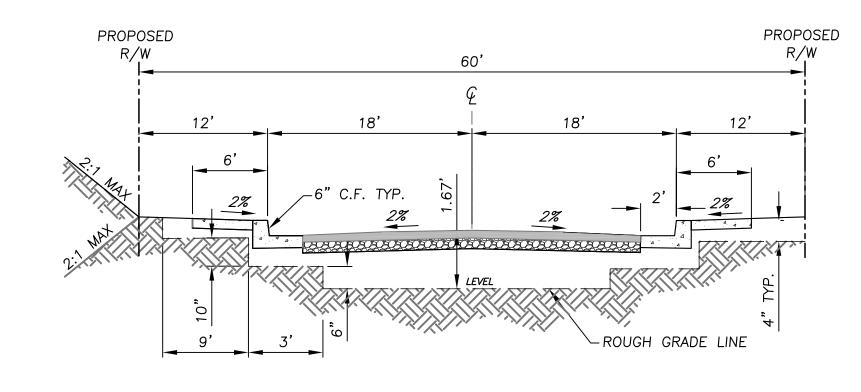N.T.S.



TYPICAL SECTION STREET ROUGH GRADING

DIG ALERT

TOLL FREE

1-800-227-2600

48 HOURS BEFORE YOU DIG

BENCHMARK:

CITY OF RIVERSIDE BM# D3—A2; P.K. NAIL AND TAG AT NORTHERLY CORNER OF A CONCRETE SLAB AT THE SOUTHERLY CORNER OF LA SIERRA AVE. AND THE WESTERLY INTERSECTION OF DUFFERIN AVE.

ELEVATION: 882.135'

(1988 ELEVATION)

CITY OF RIVERSIDE, CALIFORNIA PLANNING DIVISION CITY OF RIVERSIDE BUSINESS TAX ACCOUNT #74172 EXP. 7/31/18

SAFE ENGINEERS, INC.

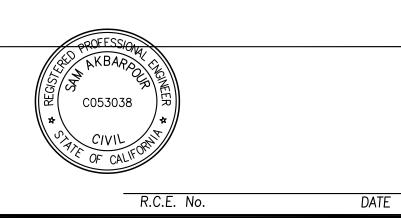
WWW.sakeengineers.com

ENGINEERING • SURVEYING • LAND DEVELOPMENT


400 S. RAMONA AVE., STE. 202

CORONA, CALIFORNIA 92879

(951) 279-4041 FAX: (951) 279-2830



			WDID #8 33C379764			PW17-0496				
					SECTIONS AND DETAILS TRACT 37764					
					SCALE: 1"=40' DRAWN: RL			CITY OF RIVERSIDE		
					DATE: 7-9-2019	DESIGNED: RL	DEPARTMENT OF PUBLIC WORKS			
					JOB NO.: JN3053	CHECKED: SA	W			
_ 	ARK	REVISIONS	APPROVED	DATE	CAME PG. XX-X M.P. X	520-769200-470701	٧٧	SHEET 2 of 5		

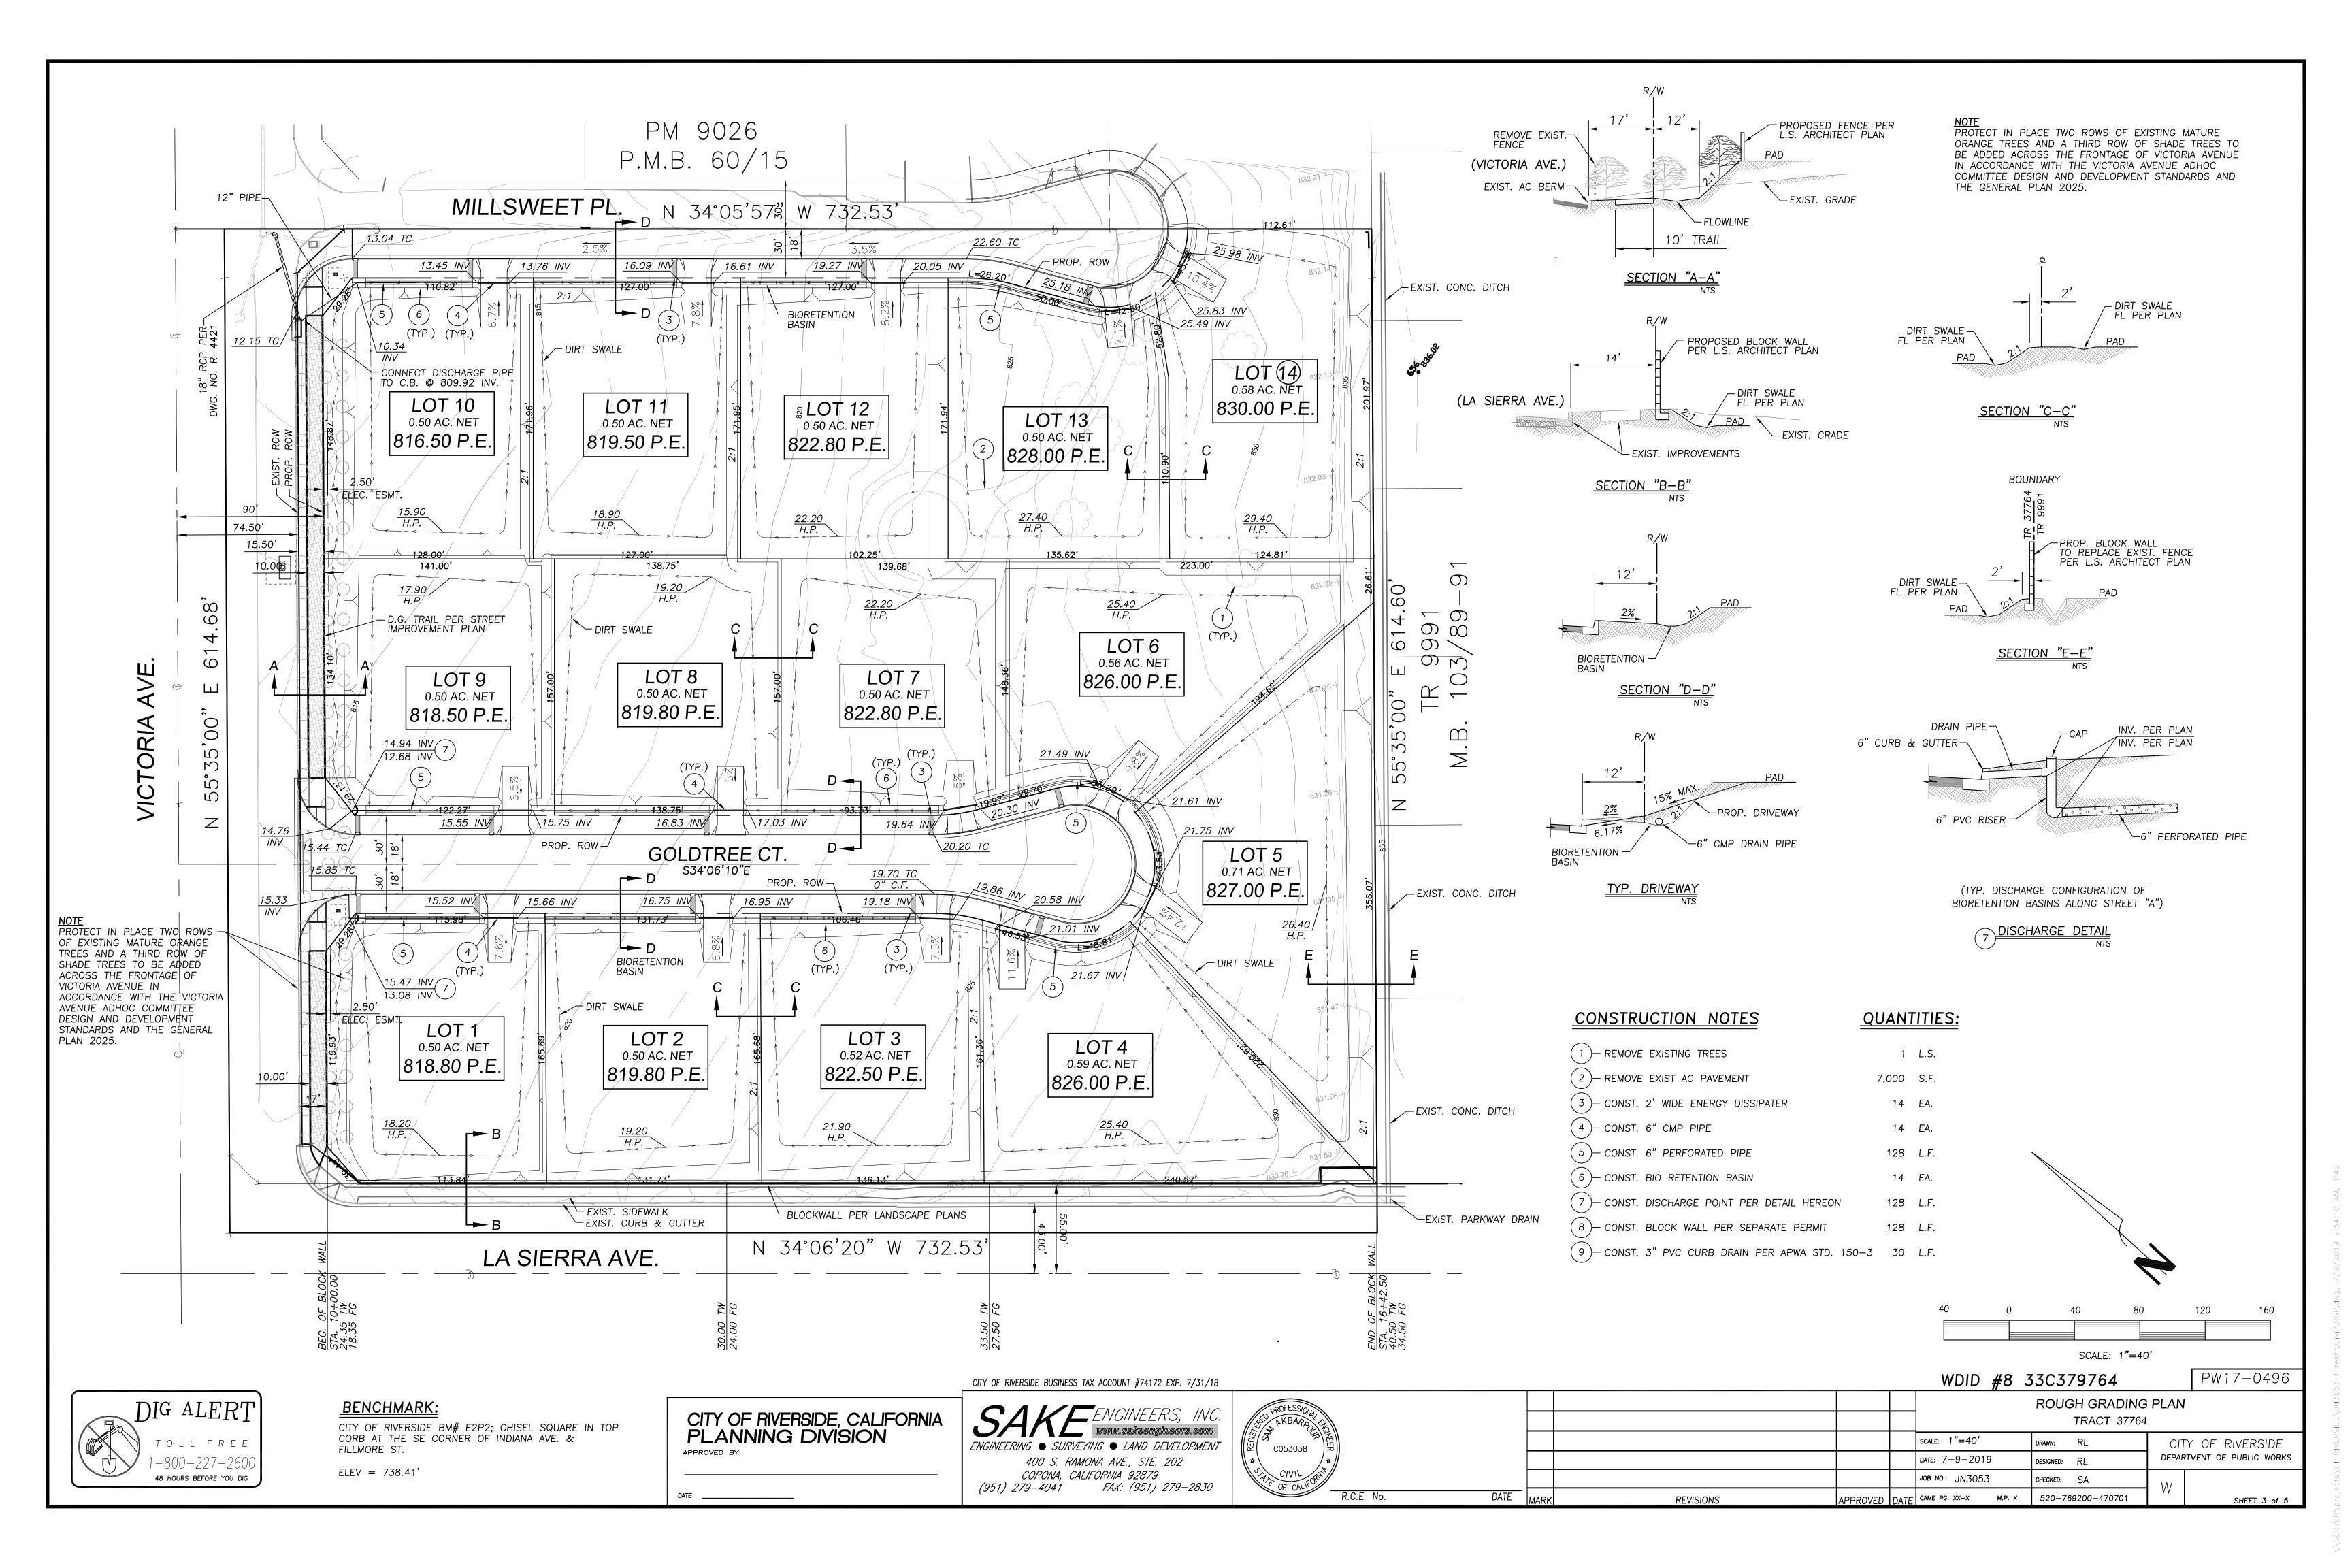



EROSION CONTROL NOTES

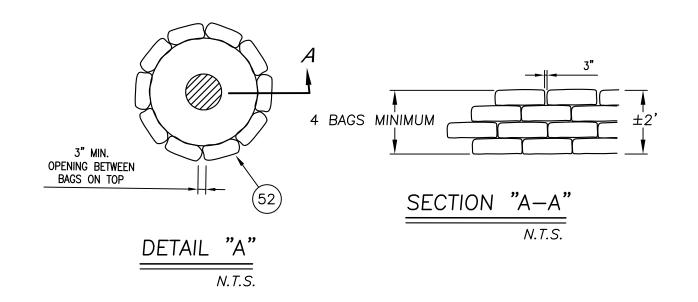
- 1. IN CASE OF EMERGENCY, CALL: <u>HITESH PATEL</u>

 WORK: <u>(760) 963-3475</u>

 FMAIL:
- 2. EQUIPMENT AND WORKERS FOR EMERGENCY WORK SHALL BE MADE AVAILABLE AT ALL TIMES DURING THE RAINY SEASON. NECESSARY MATERIALS SHALL BE AVAILABLE ON SITE AND STOCKPILED AT CONVENIENT LOCATIONS TO FACILITATE RAPID CONSTRUCTION OF TEMPORARY DEVICES WHEN RAIN IS IMMINENT.
- 3. DEVICES SHALL NOT BE MOVED OR MODIFIED WITHOUT THE APPROVAL OF THE ENGINEERING DEPARTMENT.
- 4. ALL REMOVABLE PROTECTIVE DEVICES SHOWN SHALL BE IN PLACE AT THE END OF EACH WORKING DAY WHEN THE 5—DAY RAIN PROBABILITY FORECAST EXCEEDS 40%.
- 5. AFTER A RAINSTORM, ALL SILT AND DEBRIS SHALL BE REMOVED FROM CHECK BERMS AND DESILTING BASINS, AND THE BASINS PUMPED DRY.
- GRADED AREAS AROUND THE TRACT PERIMETER MUST DRAIN AWAY FROM THE FACE OF SLOPE AT THE CONCLUSION OF EACH WORKING DAY.
- 7. THE CONTRACTOR SHALL BE RESPONSIBLE AND SHALL TAKE NECESSARY PRECAUTIONS TO PREVENT PUBLIC TRESPASS ONTO AREAS WHERE IMPOUNDED WATER CREATES A HAZARDOUS CONDITION.
- 8. GRAVEL BAG LAYOUT SHALL BE INSTALLED AS SHOWN PER PLAN OR AS DIRECTED BY THE CITY INSPECTOR.


SITE PREPARATION:

- 1 THE EMBANKMENT FOUNDATION AREA SHALL BE CLEARED OF ALL TREES, ROOTS, BRUSH, BOULDERS, SOD, AND DEBRIS.
- 2 ALL TOPSOIL CONTAINING EXCESSIVE AMOUNTS OF ORGANIC MATTER SHALL BE REMOVED.
- 3 ALL STORM DRAIN INLETS SHALL BE CAPPED AND/OR CATCH BASINS SHALL BE PROTECTED W/FILTER FABRIC HELD DOWN BY SANDBAGS AROUND BASINS.



GRAVELBAG DRAIN PROTECTION

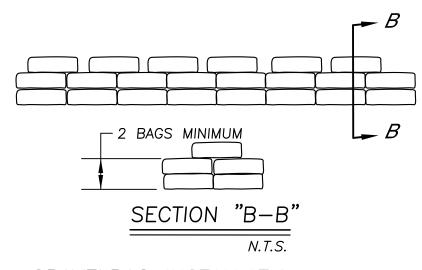N.T.S. 52




GRAVELBAG INSTALLATION

N.T.S.

51

CONSTRUCTION NOTES:

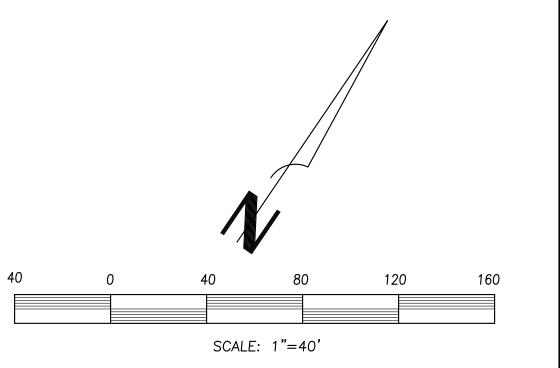- (50)— CONST. STABILIZED ENTRANCE PER DETAIL ON SHT. 5
 (51)— INSTALL GRAVEL BAGS PER DETAIL HEREON
- (52)—INSTALL GRAVELBAG DRAIN PROTECTION PER DETAIL HEREON






BENCHMARK:

CITY OF RIVERSIDE BM# E2P2; CHISEL SQUARE IN TOP CORB AT THE SE CORNER OF INDIANA AVE. & FILLMORE ST.


ELEV = 738.41'

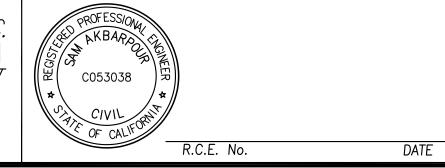CITY OF RIVERSIDE, CALIFORNIA PLANNING DIVISION






WDID #8 33C379764							PW17-0496	
				EROSION CONTROL PLAN TRACT 37764				
				TRACT 37704				
				scale: 1"=40' DRAWN: RL		CIT	CITY OF RIVERSIDE	
				ATE: 7-9-2019 DESIGNED: RL DEPARTMENT OF PUBLIC WOR			MENT OF PUBLIC WORKS	
				JOB NO.: JN3053	CHECKED: SA	W		
MARK	REVISIONS	APPROVED	DATE	CAME PG. XX-X M.P. X	520-769200-470701	٧٧	SHEET 4 of 5	

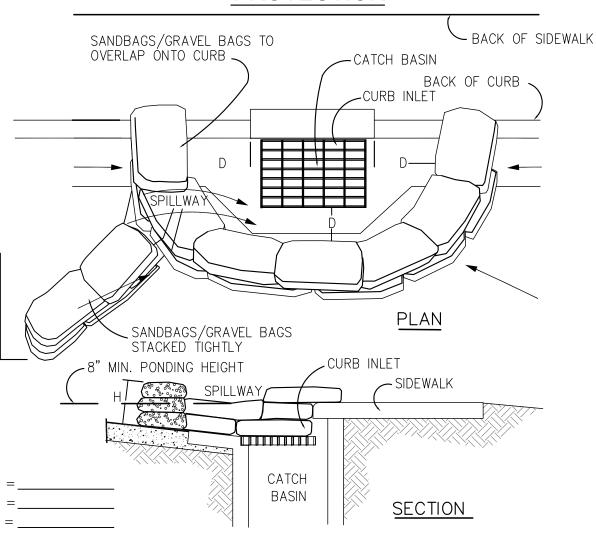


- 1. CATCH BASIN/INLET PROTECTION SHALL BE INSTALLED WHEREVER THERE IS A POTENTIAL OF STORMWATER OR NON-STORMWATER BEING DISCHARGED INTO IT.
- 2. INLET PROTECTION IS REQUIRED ALONG WITH OTHER POLLUTION PREVENTION MEASURES SUCH AS; EROSION CONTROL, SOIL STABILIZATION, AND MEASURES TO PREVENT TRACKING ONTO
- 3. MODIFY INLET PROTECTION AS NEEDED TO AVOID CREATING TRAFFIC HAZARDS.
- 4. INCLUDE INLET PROTECTION MEASURES AT HILLSIDE V-DITCHES AND MISC. DRAINAGE SWALES. INLET PROTECTION SHALL BE INSPECTED AND ACCUMULATED SEDIMENTS REMOVED. SEDIMENT
- SHALL BE DISPOSED OF PROPERLY AND IN A MANNER THAT ASSURES THAT THE SEDIMENT DOES NOT ENTER THE STORM DRAIN SYSTEM
- DAMAGED BAGS SHALL BE REPLACED IMMEDIATELY.
- 7. ADDITIONAL SANDBAG SEDIMENT TRAPS SHALL BE PLACED AT INTERVALS AS INDICATED ON

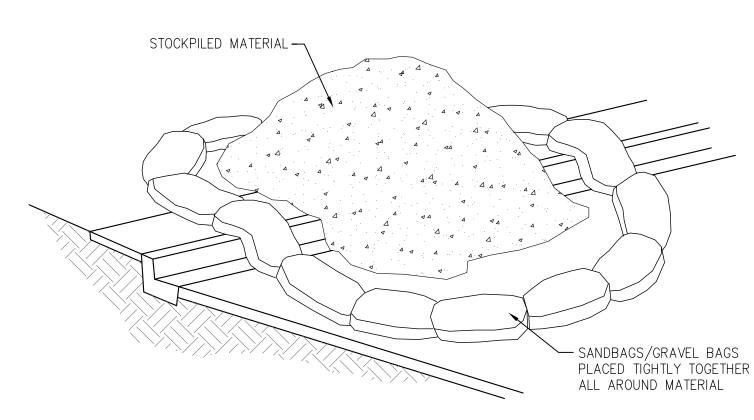MATERIAL STORAGE




NOTES:

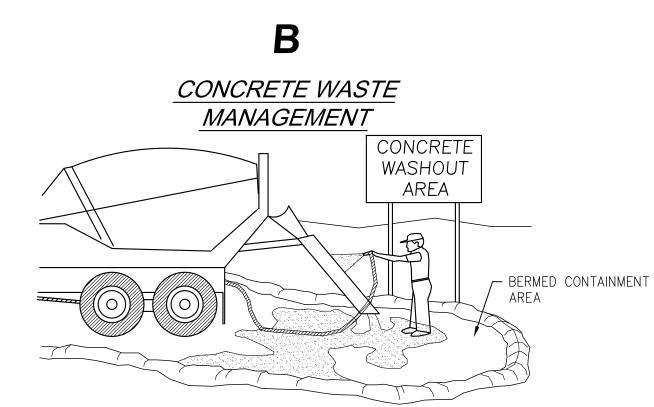- 1. DIRT AND OTHER CONSTRUCTION RELATED MATERIALS PLACED IN THE STREET OR ON OTHER IMPERVIOUS SURFACES MUST BE CONTAINED WITH SANDBAGS OR OTHER MEASURES TO PREVENT TRANSPORT TO THE STORMDRAIN SYSTEM.
- 2. ANY CONSTRUCTION MATERIAL STORED OR STOCKPILED ON-SITE SHALL BE PROTECTED FROM BEING TRANSPORTED BY THE FORCE OF WIND OR WATER.



- 1. EXCESS AND WASTE CONCRETE SHALL NOT BE WASHED INTO THE STREET OR INTO A DRAINAGE SYSTEM.
- 2. FOR WASHOUT OF CONCRETE AND MORTAR PRODUCTS, A DESIGNATED CONTAINMENT FACILITY OF SUFFICIENT CAPACITY TO RETAIN LIQUID AND SOLID WASTE SHALL BE PROVIDED ON SITE.
- 3. SLURRY FROM CONCRETE AND ASPHALT SAW CUTTING SHALL BE VACUUMED OR CONTAINED, DRIED, PICKED UP AND DISPOSED OF PROPERLY.

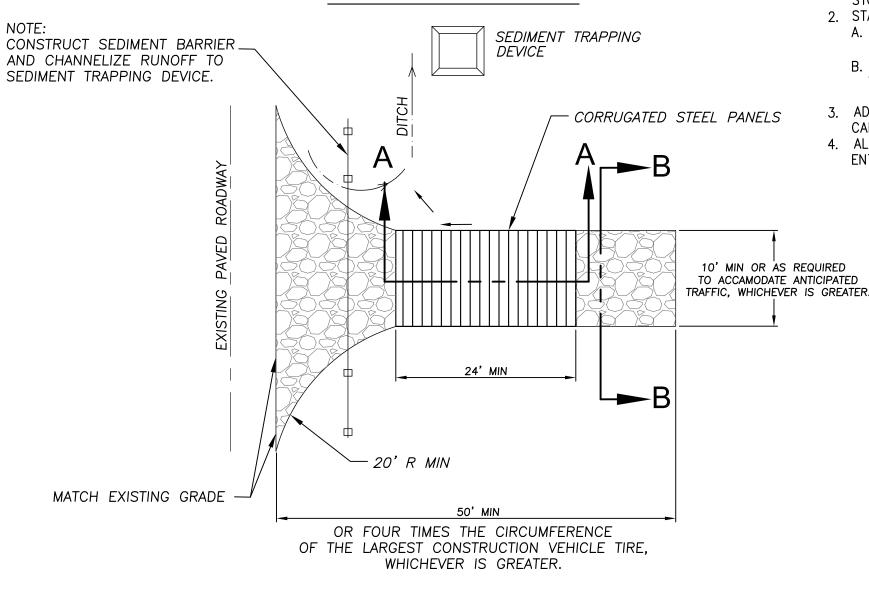STABILIZED CONSTRUCTION ENTRANCE / EXIT TC1



STREET MAINTENANCE

- 1. REMOVE ALL SEDIMENT DEPOSITED ON PAVED ROADWAYS IMMEDIATELY. 2. SWEEP PAVED AREAS THAT RECEIVE CONSTRUCTION TRAFFIC WHENEVER
- SEDIMENT BECOMES VISIBLE.
- 3. PAVEMENT WASHING WITH WATER IS PROHIBITED IF IT RESULTS IN A DISCHARGE TO THE STORM DRAIN SYSTEM.

EQUIPMENT

REPAIR/MAINTENANCE

STORMWATER POLLUTION

1. SEDIMENTS AND OTHER MATERIALS SHALL NOT BE TRACKED FROM THE SITE BY VEHICLE

STORM DRAIN SYSTEM.

PAVED SURFACES.

CAN GREATLY IMPROVE EFFICIENCY.

2. STABILIZED CONSTRUCTION ENTRANCE SHALL BE:

12" MIN, UNLESS OTHERWISE SPECIFIED BYA SOILS ENGINEER

TRAFFIC. THE CONSTRUCTION ENTRANCE ROADWAYS SHALL BE STABILIZED SO AS TO PREVENT

A. LOCATED AT ANY POINT WHERE TRAFFIC WILL BE ENTERING OR LEAVING A CONSTRUCTION SITE

TO OR FROM A PUBLIC RIGHT OF WAY, STREET, ALLEY, AND SIDEWALK OR PARKING AREA.

WITH LENGTH, WIDTH & THICKNESS AS NEEDED TO ADEQUATELY PREVENT ANY TRACKING ONTO

CRUSHED AGGREGATE GREATER THAN 3"

SECTION B-B

FILTER FABRIC

- CORRUGATED STEEL PANELS

BUT SMALLER THAN 6". FILTER FABRIC

CRUSHED AGGREGATE GREATER THAN 3"

SECTION A-A

BUT SMALLER THAN 6".

B. A SERIES OF STEEL PLATES WITH "RUMBLE STRIPS", AND/OR MIN 4" COARSE AGGREGATE

ADDING A WASH RACK WITH A SEDIMENT TRAP LARGE ENOUGH TO COLLECT ALL WASH WATER

4. ALL VEHICLES ACCESSING THE CONSTRUCTION SITE SHALL UTILIZE THE STABILIZED CONSTRUCTION

SEDIMENTS FROM BEING DEPOSITED INTO THE PUBLIC ROADS. DEPOSITIONS MUST BE SWEPT

UP IMMEDIATELY AND MAY NOT BE WASHED DOWN BY RAIN OR OTHER MEANS INTO THE

GENERAL NOTES

12" MIN, UNLESS OTHERWISE

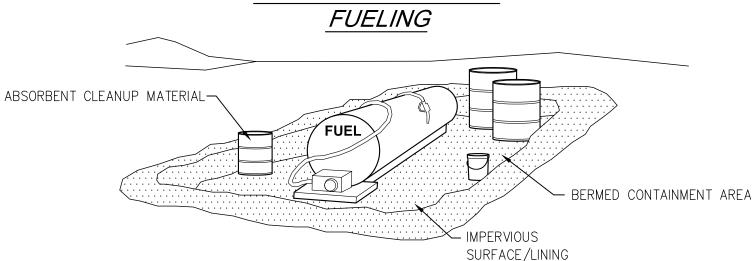
SPECIFIED BYA SOILS ENGINEER

1. BEST MANAGEMENT PRACTICES (BMP'S) CONTAINED HEREIN REFLECT MINIMUM REQUIREMENTS. FOR ADDITIONAL BMP'S REFER TO CALIFORNIA STORMWATER BMP HANDBOOKS.

CONTROL PLAN

- 2. ALL CONSTRUCTION ACTIVITY SHALL BE PERFORMED IN ACCORDANCE WITH A STORMWATER POLLUTION CONTROL PLAN (SWPCP) DEVELOPED AND IMPLEMENTED IN COMPLIANCE WITH REQUIREMENTS OF THE ORANGE COUNTYWIDE STORMWATER QUALITY MANAGEMENT PROGRAM, NATIONAL POLLUTION DISCHARGE ELIMINATION SYSTEM (NPDES) PERMIT NO.
- 3. THE SWPCP SHALL:
- A. IDENTIFY POTENTIAL POLLUTANT SOURCES AND INCLUDE THE DESIGN AND PLACEMENT OF BMP'S TO EFFECTIVELY PROHIBIT THE ENTRY OF POLLUTANTS FROM THE CONSTRUCTION SITE INTO AND ONTO THE STREET AND STORM DRAIN SYSTEM DURING
- B. BE KEPT ON SITE AND AMENDED TO REFLECT CHANGING CONDITIONS THROUGHOUT THE COARSE OF CONSTRUCTION.
- C. BE KEPT UP TO DATE. ANY ADDITIONAL UPDATES REQUESTED BY AGENCY REPRESENTATIVES ARE TO BE MADE IMMEDIATELY.
- 4. NON-STORMWATER DISCHARGES ARE PROHIBITED FROM ENTERING ANY STORM DRAIN SYSTEM AND/OR STREET.
- 5. DISCHARGES OF PUMPED GROUND WATER REQUIRE A DISCHARGE PERMIT FROM THE STATE OF CALIFORNIA REGIONAL WATER QUALITY CONTROL BOARD (RWQCB).
- 6. POLLUTANTS SHALL BE REMOVED FROM STORMWATER DISCHARGES TO THE MAXIMUM EXTENT PRACTICABLE (MEP) THROUGH DESIGN & IMPLEMENTATION OF THE SWPCP.
- 7. A STANDBY CREW FOR EMERGENCY WORK SHALL BE AVAILABLE AT ALL TIMES DURING THE RAINY SEASON (NOV. 1 TO APR. 15). NECESSARY MATERIALS SHALL BE AVAILABLE ON SITE AND STOCKPILED AT CONVENIENT LÓCATIONS TO FACILITATE RAPID CONSTRUCTION OF EMERGENCY DEVICES WHEN RAIN IS IMMINENT.
- 8. PORTABLE SANITARY FACILITIES SHALL BE LOCATED ON RELATIVELY LEVEL GROUND AWAY FROM TRAFFIC AREAS, DRAINAGE COURSES, AND STORM DRAIN INLETS.
- 9. EMPLOYEES, SUBCONTRACTORS AND SUPPLIERS SHALL BE EDUCATED ON ALL BMP'S INCLUDING CONCRETE WASTE STORAGE AND DISPOSAL PROCEDURES.
- 10. SEDIMENT CONTROL PRACTICES SHALL EFFECTIVELY PREVENT A NET INCREASE OF SEDIMENT LOAD IN STORMWATER DISCHARGE.

VEHICLE/EQUIPMENT



NOTES:

1. FUELING SHALL BE PERFORMED IN A DESIGNATED AREA, AWAY FROM DRAINAGE COURSES. 2. ABSORBENT CLEANUP MATERIAL SHALL BE ON SITE AND USED IMMEDIATELY IN THE EVENT

NOTES:

WATER.

1. LEAKING VEHICLES AND EQUIPMENT SHALL NOT BE ALLOWED ON-SITE. EQUIPMENT AND VEHICLES SHALL BE INSPECTED FREQUENTLY FOR LEAKS AND SHALL BE REPAIRED IMMEDIATELY. CLEAN UP SPILLS AND LEAKS PROMPTLY WITH ABSORBENT MATERIALS; DO NOT FLUSH WITH

CONTAINMENT AREA -

2. VEHICLES AND EQUIPMENT SHALL BE MAINTAINED, AND REPAIRED ON-SITE ONLY IN DESIGNATED AREAS. PREVENT RUN-ON AND RUN-OFF FROM DESIGNATED AREAS. CONTAINMENT DEVICES SHALL BE PROVIDED AND AREAS SHALL BE COVERED IF NECESSARY.

3. DESIGNATE ON-SITE VEHICLE AND EQUIPMENT MAINTENANCE AREAS, AWAY FROM STORM

- DRAIN INLETS AND WATERCOURSES. 4. ALWAYS USE SECONDARY CONTAINMENT, SUCH AS A DRAIN PAN OR DROP CLOTH, TO CATCH
- SPILLS AND LEAKS WHEN REMOVING OR CHANGING FLUIDS. 5. LEGALLY DISPOSE OF USED OILS, FLUIDS, AND LUBRICANTS.
- 6. PROVIDE SPILL CONTAINMENT DIKES OR SECONDARY CONTAINMENT AROUND STORED OIL, FUEL, AND CHEMICAL DRUMS.
- 7. MAINTAIN AN ADEQUATE SUPPLY OF ABSORBENT SPILL CLEANUP MATERIALS IN DESIGNATED


TOLL FREE 48 HOURS BEFORE YOU DIG

CITY OF RIVERSIDE, CALIFORNIA PLANNING DIVISION APPROVED BY

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ABSORBENT CLEANUP MATERIAL



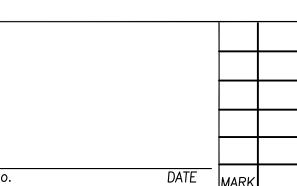PW17-0496 WDID #8 33C379764 BEST MANAGEMENT PRACTICE TRACT 37764 SCALE: 1"=40' DRAWN: RL CITY OF RIVERSIDE DEPARTMENT OF PUBLIC UTILITIES DATE: 7-9-2019 DESIGNED: RL JOB NO.: JN3053 CHECKED: SA APPROVED DATE CAME PG. XX-X M.P. X 520-769200-470701 **REVISIONS** SHEET 5 of 5